


TABLE NO. 1  
MINIMUM SIZE OF THE BRACING MEMBER FOR CEILING  
MAXIMUM SPACING OF THE BRACE

WALL HEIGHT	6'-0"	8'-0"
UP TO 10'	12 GA WIRE	12 GA WIRE
12'	10 GA WIRE	10 GA WIRE*
14'	10 GA WIRE	25 GA STUD
16'	10 GA WIRE	25 GA STUD

\* USE WITH 20 GA. HEAD RUNNER

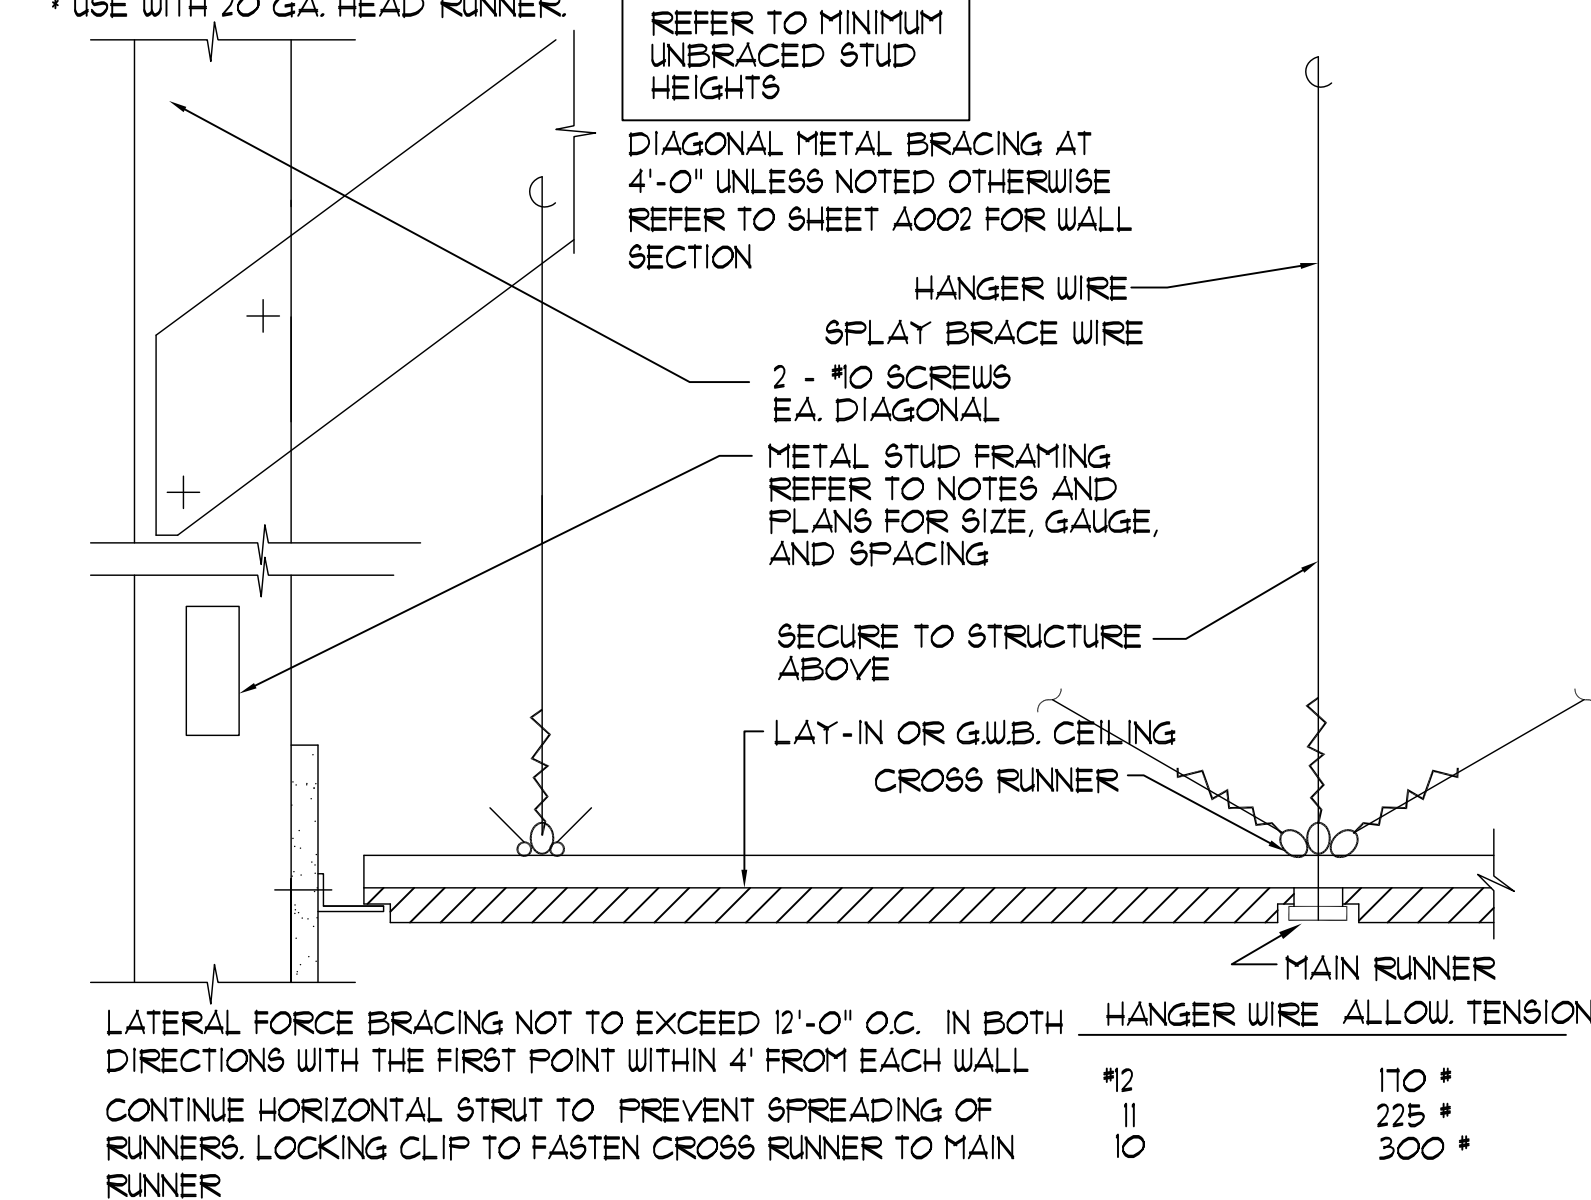

**2 CEILING DETAIL**  
SCALE: 3/4" = 1'-0"

**1 REFLECTED CEILING PLAN**  
SCALE: 1/8" = 1'-0"

**J. HOWARD NUPELL ARCHITECT**  
31690 W. Twelve Mile Road  
Farmington Hills, Michigan 48334  
1 248 324 8800 1 248 324 5550  
OFFICES IN

- Dallas, Texas 972 387 5900
- Costa Mesa, California 714 979 8100
- Chicago, Illinois 321 558 1144
- Tempe, Arizona 480 446 3300

**NOTICE**  
THIS ARCHITECTURAL AND/OR ENGINEERING DRAWING IS GIVEN IN CONFIDENCE. NO USE, IN WHOLE OR PART, MAY BE MADE WITHOUT PRIOR WRITTEN CONSENT OF NUPELL ARCHITECTS. ALL RIGHTS ARE HEREBY SPECIFICALLY RESERVED.  
NUPELL ARCHITECTS  
COPYRIGHT YEAR 2010

State of Florida  
Registered Architect  
  
Joel Howard Nuell  
Reg. No. 7953

project title  
  
**Suite - #2517**  
Interior Modification  
David's World Cycle  
**OCCUPANCY:**  
"M" Mercantile  
David's World Cycle  
2517 Edgewater Dr Orlando FL 32804

sheet title  
**REFLECTED CEILING PLAN**  
  
DO NOT SCALE DRAWINGS  
USE FIGURED DIMENSIONS ONLY

project number  
**2010-041**  
  
drawn SCT  
checked SCT  
approved CM

issued for date  
OWNER ISSUE 03-11-10  
OWNER ISSUE 03-18-10  
PRICING ISSUE 03-29-10  
PERMIT ISSUE 03-29-10

sheet  
**A202**