

1 FOUNDATION PLAN
 SCALE: 1/8" = 1'-0"
 REF. 1/8" = 1'-0"

MARK	SIZE	DEPTH	TOP REINFORCEMENT	BOTTOM REINFORCEMENT
F-5	5'-0" SQUARE	12	6X6XW2.9XW2.9 W.W.F.	(8) #5 E.W.
F-6	6'-0" SQUARE	14	6X6XW2.9XW2.9 W.W.F.	(9) #5 E.W.
F-7	7'-0" SQUARE	16	6X6XW2.9XW2.9 W.W.F.	(7) #7 E.W.
F-8	8'-0" SQUARE	18	6X6XW2.9XW2.9 W.W.F.	(8) #7 E.W.
F-9	9'-0" SQUARE	20	6X6XW2.9XW2.9 W.W.F.	(9) #7 E.W.
F2.0	2'-0" CONT	12	N/A	(3) #5 CONT
F5.0	5'-0" CONT	16	(5) #5 CONT	#5 @ 12" O.C. TRANS.
F6.0	6'-0" CONT	22	(6) #5 CONT	(6) #5 CONT #5 @ 12" O.C. TRANS.

MARK	DESIGNATION	BASE PLATE	REINF.	NOTES
COL 'M'	HSS8X8X1/4	A	N/A	N/A
COL 'B'	HSS8X8X1/4	B	N/A	N/A
COL 'C'	HSS8X8X3/8	B	N/A	N/A

MARK	SIZE	MATERIAL	THK.	ANCHOR BOLTS
A	14"X14"	A36 STL.	1"	(4) 1" THREADED HEADED STUDS [ASTM 1554 GRADE 36]
B	16"X16"	A36 STL.	1"	(4) 1" THREADED HEADED STUDS [ASTM 1554 GRADE 36]

MARK	DESIGNATION	TIES	VERT. REINF.	NOTES
MC-16	8X8	N/A	(2) #5 EA. CELL	REF. S002-13
MC-28	8X16	N/A	(2) #5 EA. CELL	REF. S002-13
MC-38	8X24	N/A	(2) #5 EA. CELL	REF. S002-13
MC-48	8X32	N/A	(2) #5 EA. CELL	REF. S002-13

MARK	DESIGNATION	FROM	TO	NOTES
BR#	-	-	-	NOT USED

GENERAL NOTES

UNLESS OTHERWISE NOTED, INSTALL (2) #5 VERTICAL BAR (EDGE) IN CONCRETE FILLED CELL AT 24" O.C. PROVIDE SAME FILLED CELL AT EACH SIDE OF ALL OPENINGS, EACH SIDE OF CONTROL JOINTS AND EXPANSION JOINTS, (2) FILLED CELLS AT WALL ENDS, AND (3) FILLED CELLS AT CORNERS.

INTERIOR FOOTINGS HEREIN ARE RELATIVE TO FINISHED FLOOR ELEVATION OF 0'-0". THE TOP OF ALL INTERIOR FOOTINGS SHALL BE THUS [2-2].


EXTERIOR FOOTINGS HEREIN ARE RELATIVE TO ADJACENT GRADE. THE TOP OF ALL EXTERIOR FOOTINGS SHALL BE THUS [1-1].

REFERENCE ARCHITECTURAL DRAWINGS FOR LOCATIONS AND CONSTRUCTION OF NON-LOAD BEARING MTL. STUD WALLS, FIXTURES, AND OTHER ITEMS NOT PRESENTED HEREIN.

4" CONCRETE SLAB W/ 3000 PSI CONC. W/ 6X6 W2.1XW2.1 W.W.F. OVER 6 MIL MIN VAPOR BARRIER ON THERMITE TREATED COMPACTED SOIL. (TYP. U.O.N.)

C.J. = CONTROL JOINT / CONSTRUCTION JOINT, TO BE COORDINATED (REF. SUBMITTAL SECTION OF GENERAL NOTES). CONTROL JOINTS SHALL BE 1" DEEP SAW CUTS TO BE MADE WITHIN 24 HRS OF POUR.

OPENING/ RE-ENTRANT CORNER, TYP. PROVIDE (2) #4 REBAR X 4'-0" LONG AT MID-HEIGHT OF SLAB

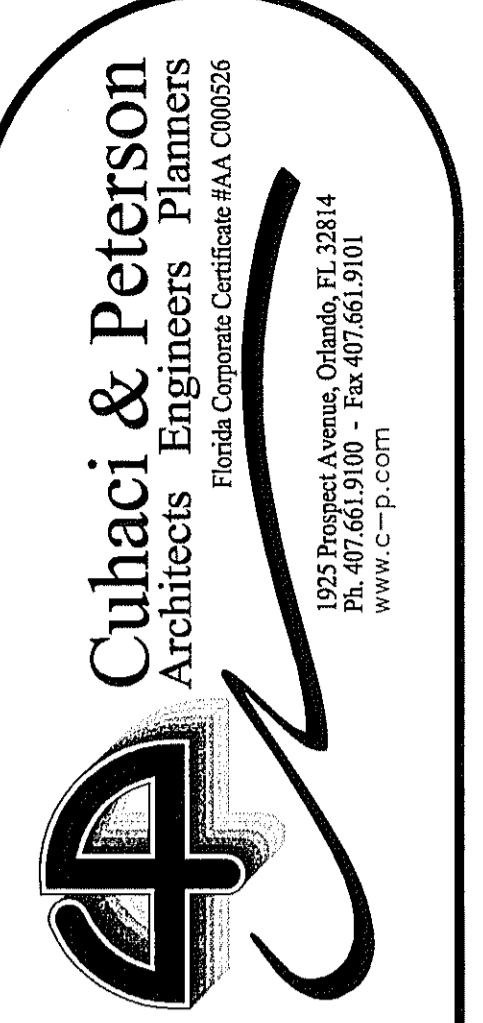

CLIENT NAME
 Weingarten Realty Investors, Inc.
 2720 E. Colonial Drive
 Orlando, FL 32803

PROJECT NAME
 Outparcel 5 @ Palm Coast Landing
 N.E.C. SR 100 and Belle Terre Parkway
 Palm Coast, Florida

SHEET TITLE
 FOUNDATION PLAN

PROJECT NO.	230550
DATE	08/28/08
DRAWN	JK
CHECKED	BR

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